




KEY PLAN - 1:2500

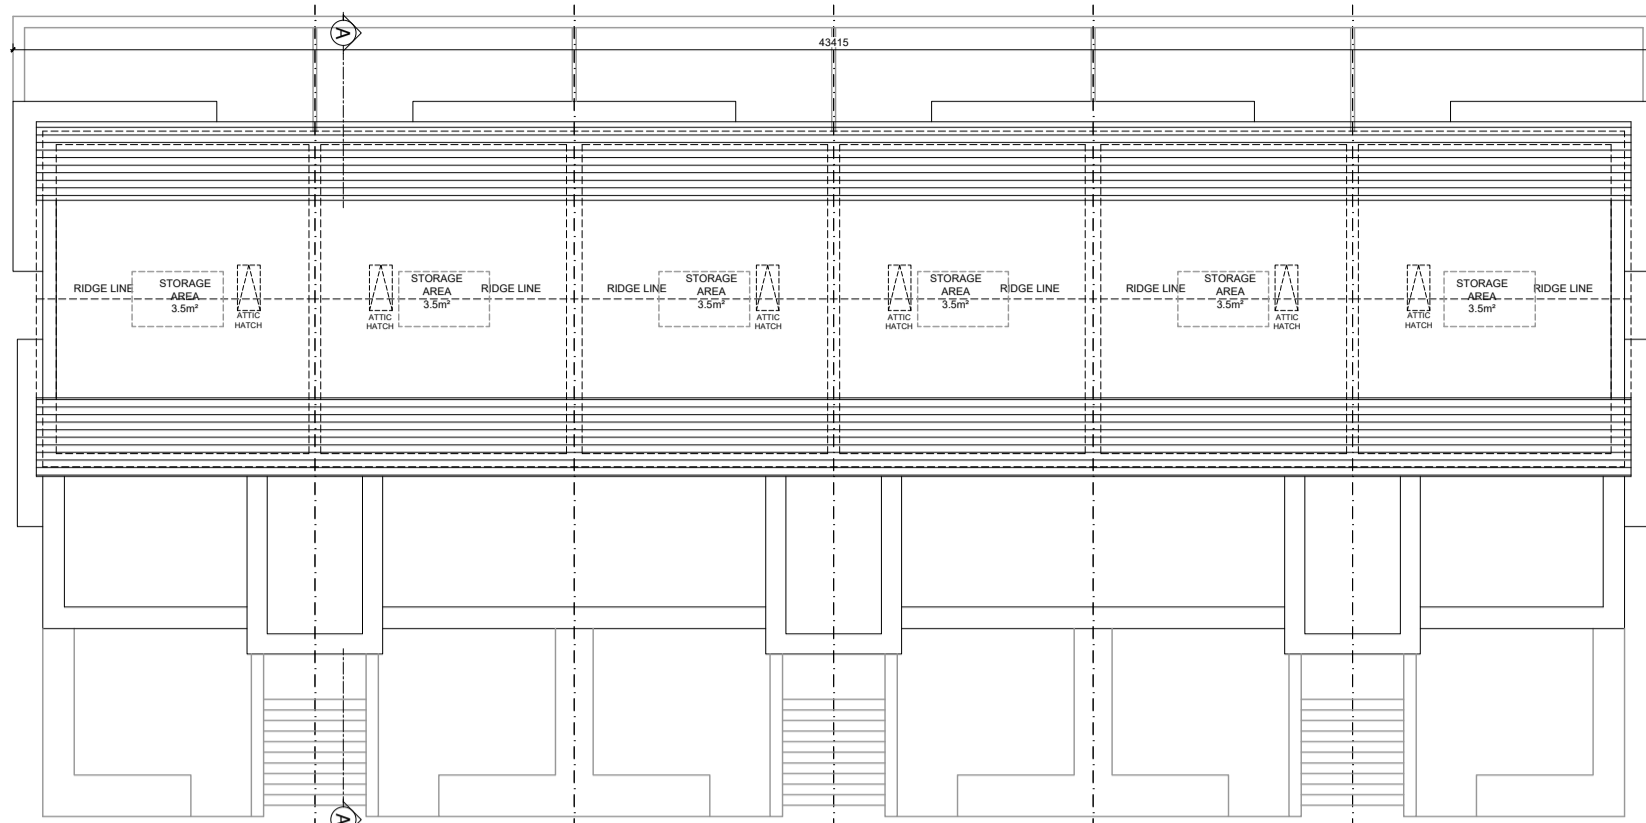


ATTIC PLAN - Units Types: A7-A3-A3-A3-A7 (minimum usable storage area per unit as indicated)

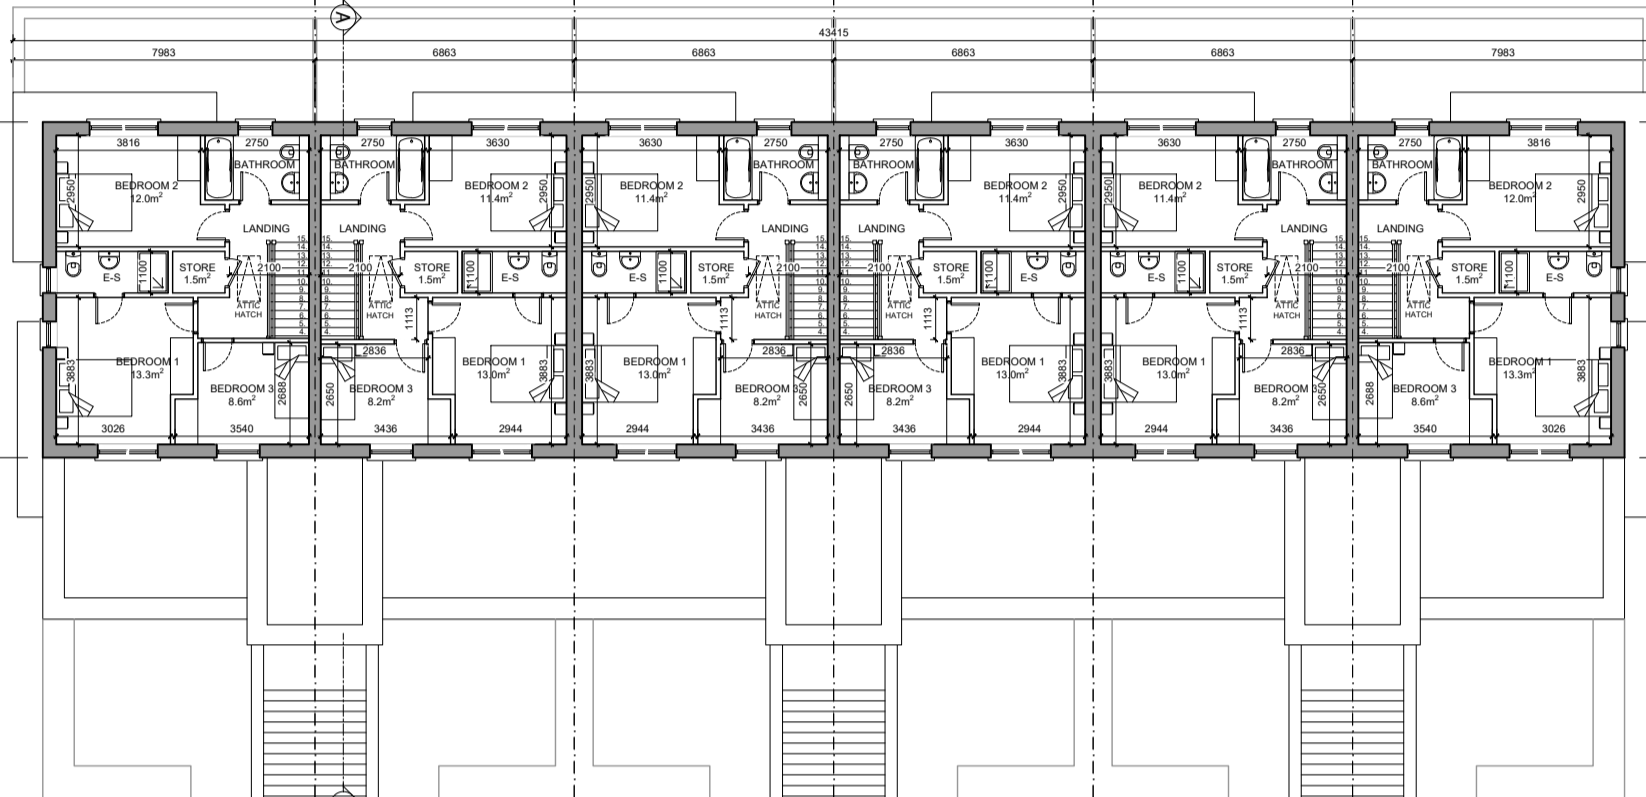

N.73 DUPLEX A7 SECOND FLOOR PLAN 2F Area = 54.6 m² (O/A Area 120.5 m²)
N.74 DUPLEX A3 SECOND FLOOR PLAN 2F Area = 53.1 m² (O/A Area 111.4 m²)
N.75 DUPLEX A3 SECOND FLOOR PLAN 2F Area = 53.1 m² (O/A Area 111.4 m²)
N.76 DUPLEX A3 SECOND FLOOR PLAN 2F Area = 53.1 m² (O/A Area 111.4 m²)
N.77 DUPLEX A3 SECOND FLOOR PLAN 2F Area = 53.1 m² (O/A Area 111.4 m²)
N.78 DUPLEX A7 SECOND FLOOR PLAN 2F Area = 54.6 m² (O/A Area 120.5 m²)


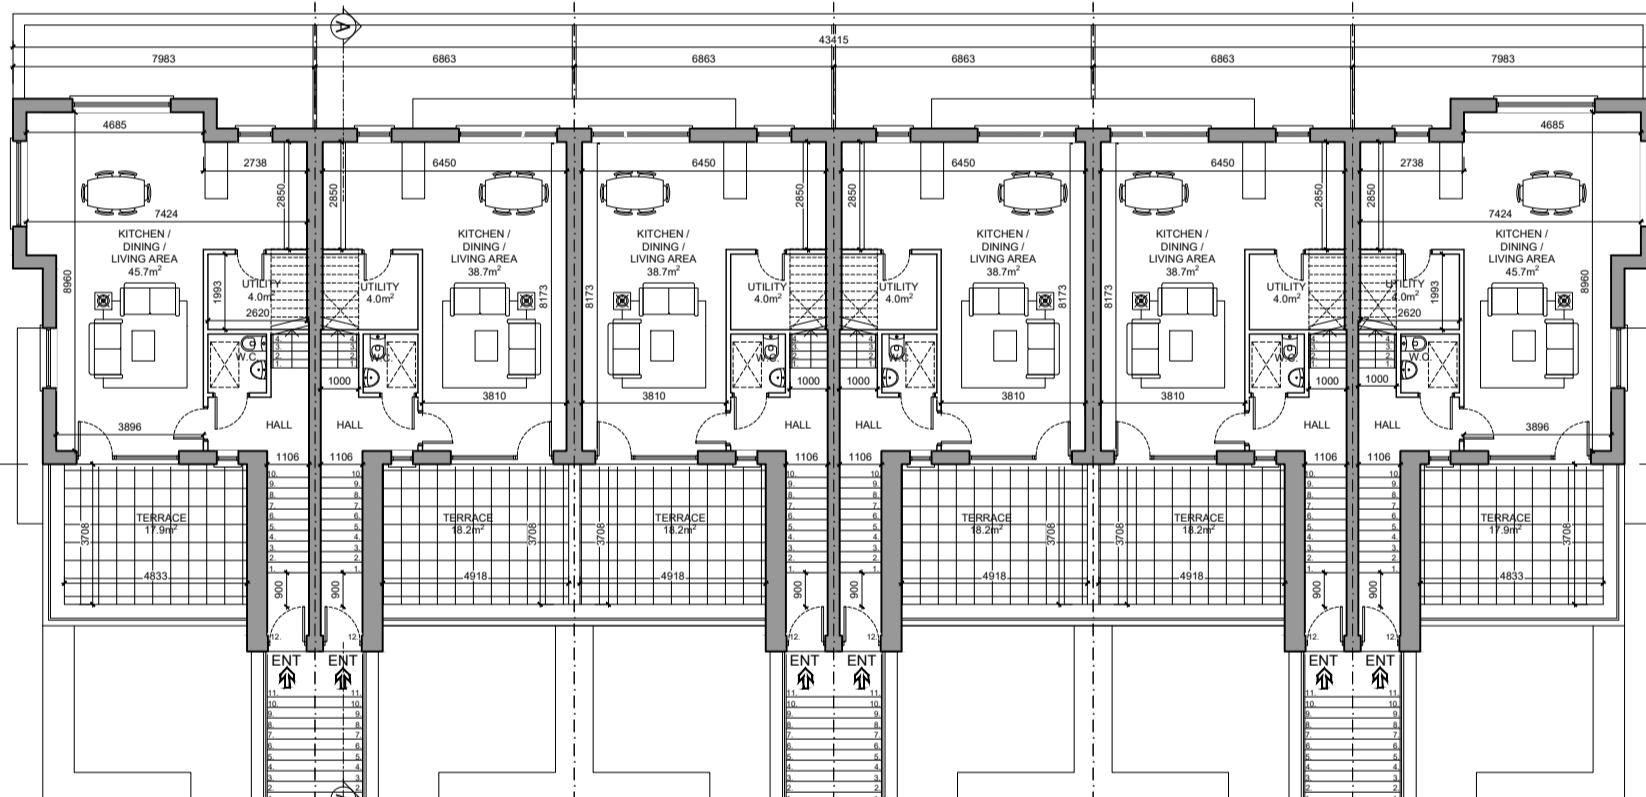


N.73 DUPLEX A7 FIRST FLOOR PLAN 1F Area = 65.9 m² (O/A Area 120.5 m²)
N.74 DUPLEX A3 FIRST FLOOR PLAN 1F Area = 58.3 m² (O/A Area 111.4 m²)
N.75 DUPLEX A3 FIRST FLOOR PLAN 1F Area = 58.3 m² (O/A Area 111.4 m²)
N.76 DUPLEX A3 FIRST FLOOR PLAN 1F Area = 58.3 m² (O/A Area 111.4 m²)
N.77 DUPLEX A3 FIRST FLOOR PLAN 1F Area = 58.3 m² (O/A Area 111.4 m²)
N.78 DUPLEX A7 FIRST FLOOR PLAN 1F Area = 65.9 m² (O/A Area 120.5 m²)

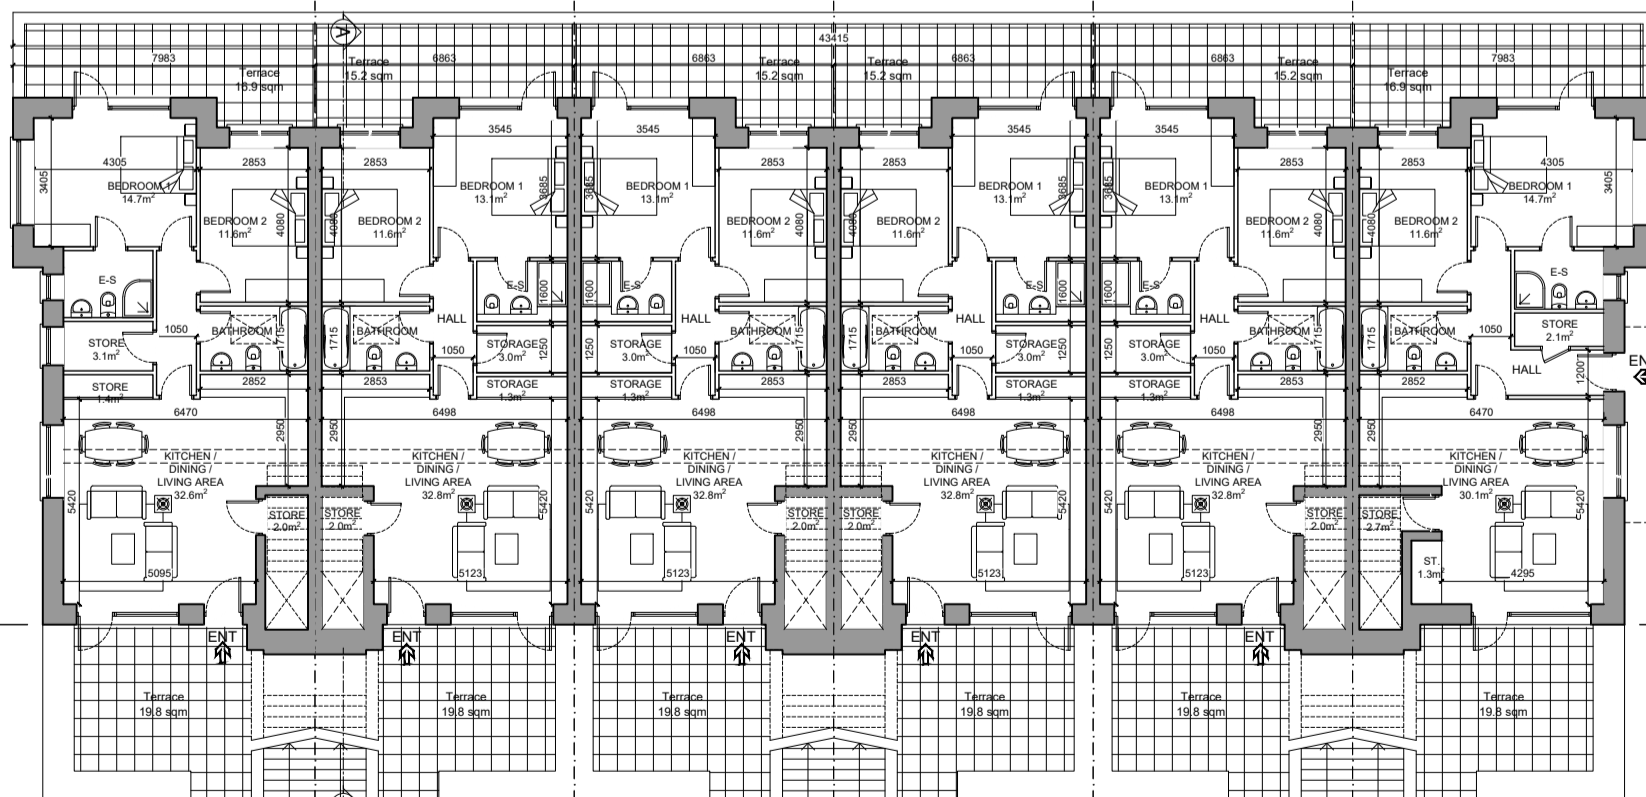

N.67 APARTMENT A11 GROUND FLOOR PLAN Area = 84.3 m²
N.68 APARTMENT A1 GROUND FLOOR PLAN Area = 82.0 m²
N.69 APARTMENT A1 GROUND FLOOR PLAN Area = 82.0 m²
N.70 APARTMENT A1 GROUND FLOOR PLAN Area = 82.0 m²
N.71 APARTMENT A1 GROUND FLOOR PLAN Area = 82.0 m²
N.72 APARTMENT A6 GROUND FLOOR PLAN Area = 84.3 m²


GROUND, FIRST SECOND FLOOR AND ATTIC PLAN SCALE 1:200

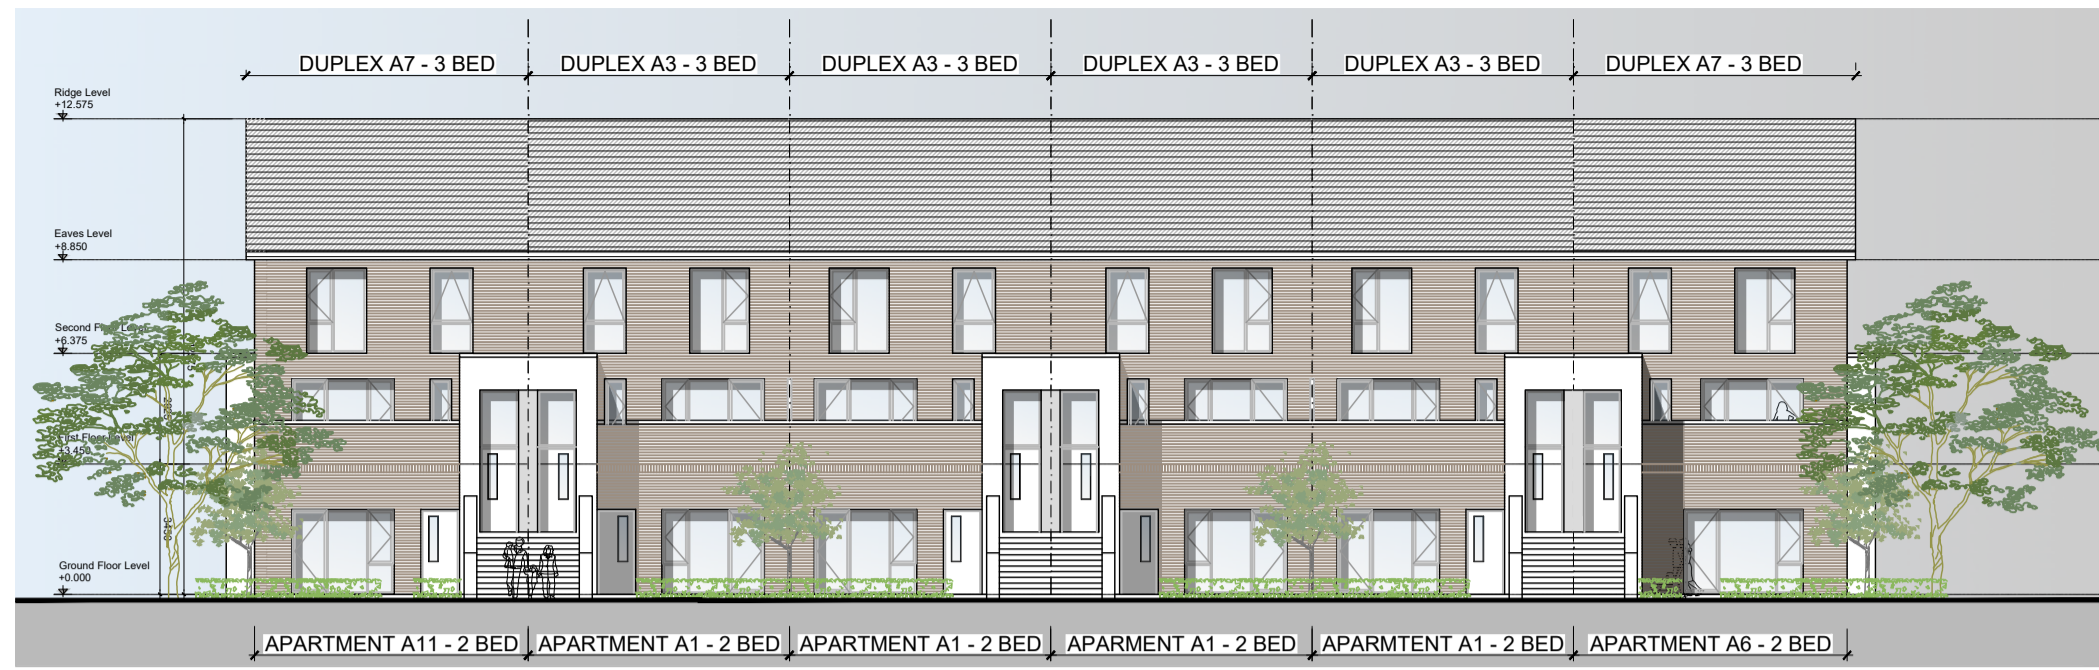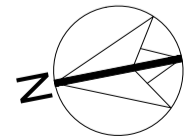


NORTH-WEST ELEVATION Scale 1:200




SOUTH-EAST ELEVATION Scale 1:200

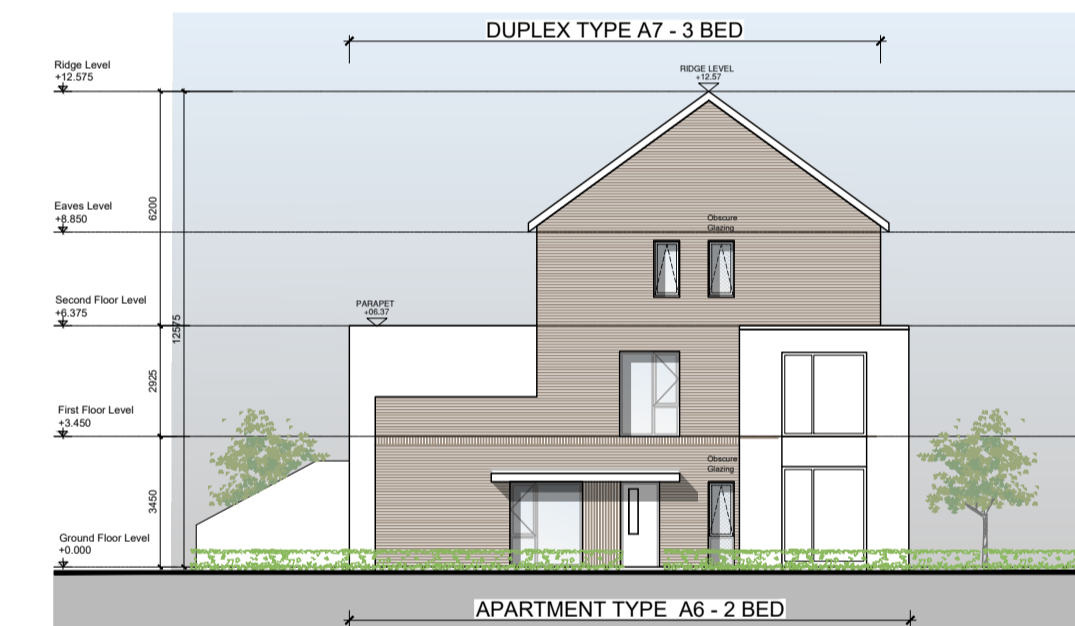


SOUTH-WEST ELEVATION Scale 1:200

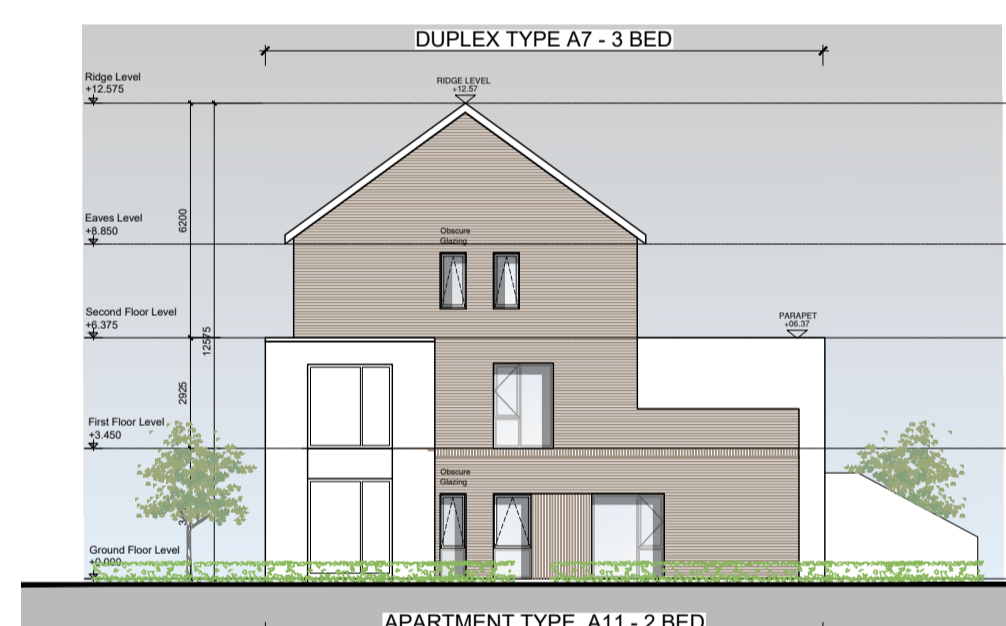

NORTH-EAST ELEVATION Scale 1:200

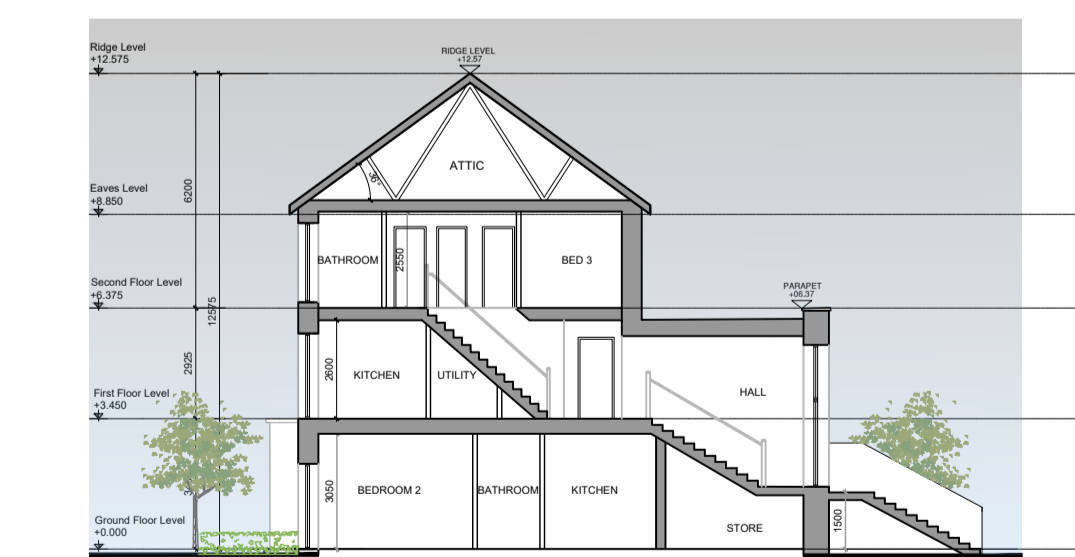

SECTION AA Scale 1:200

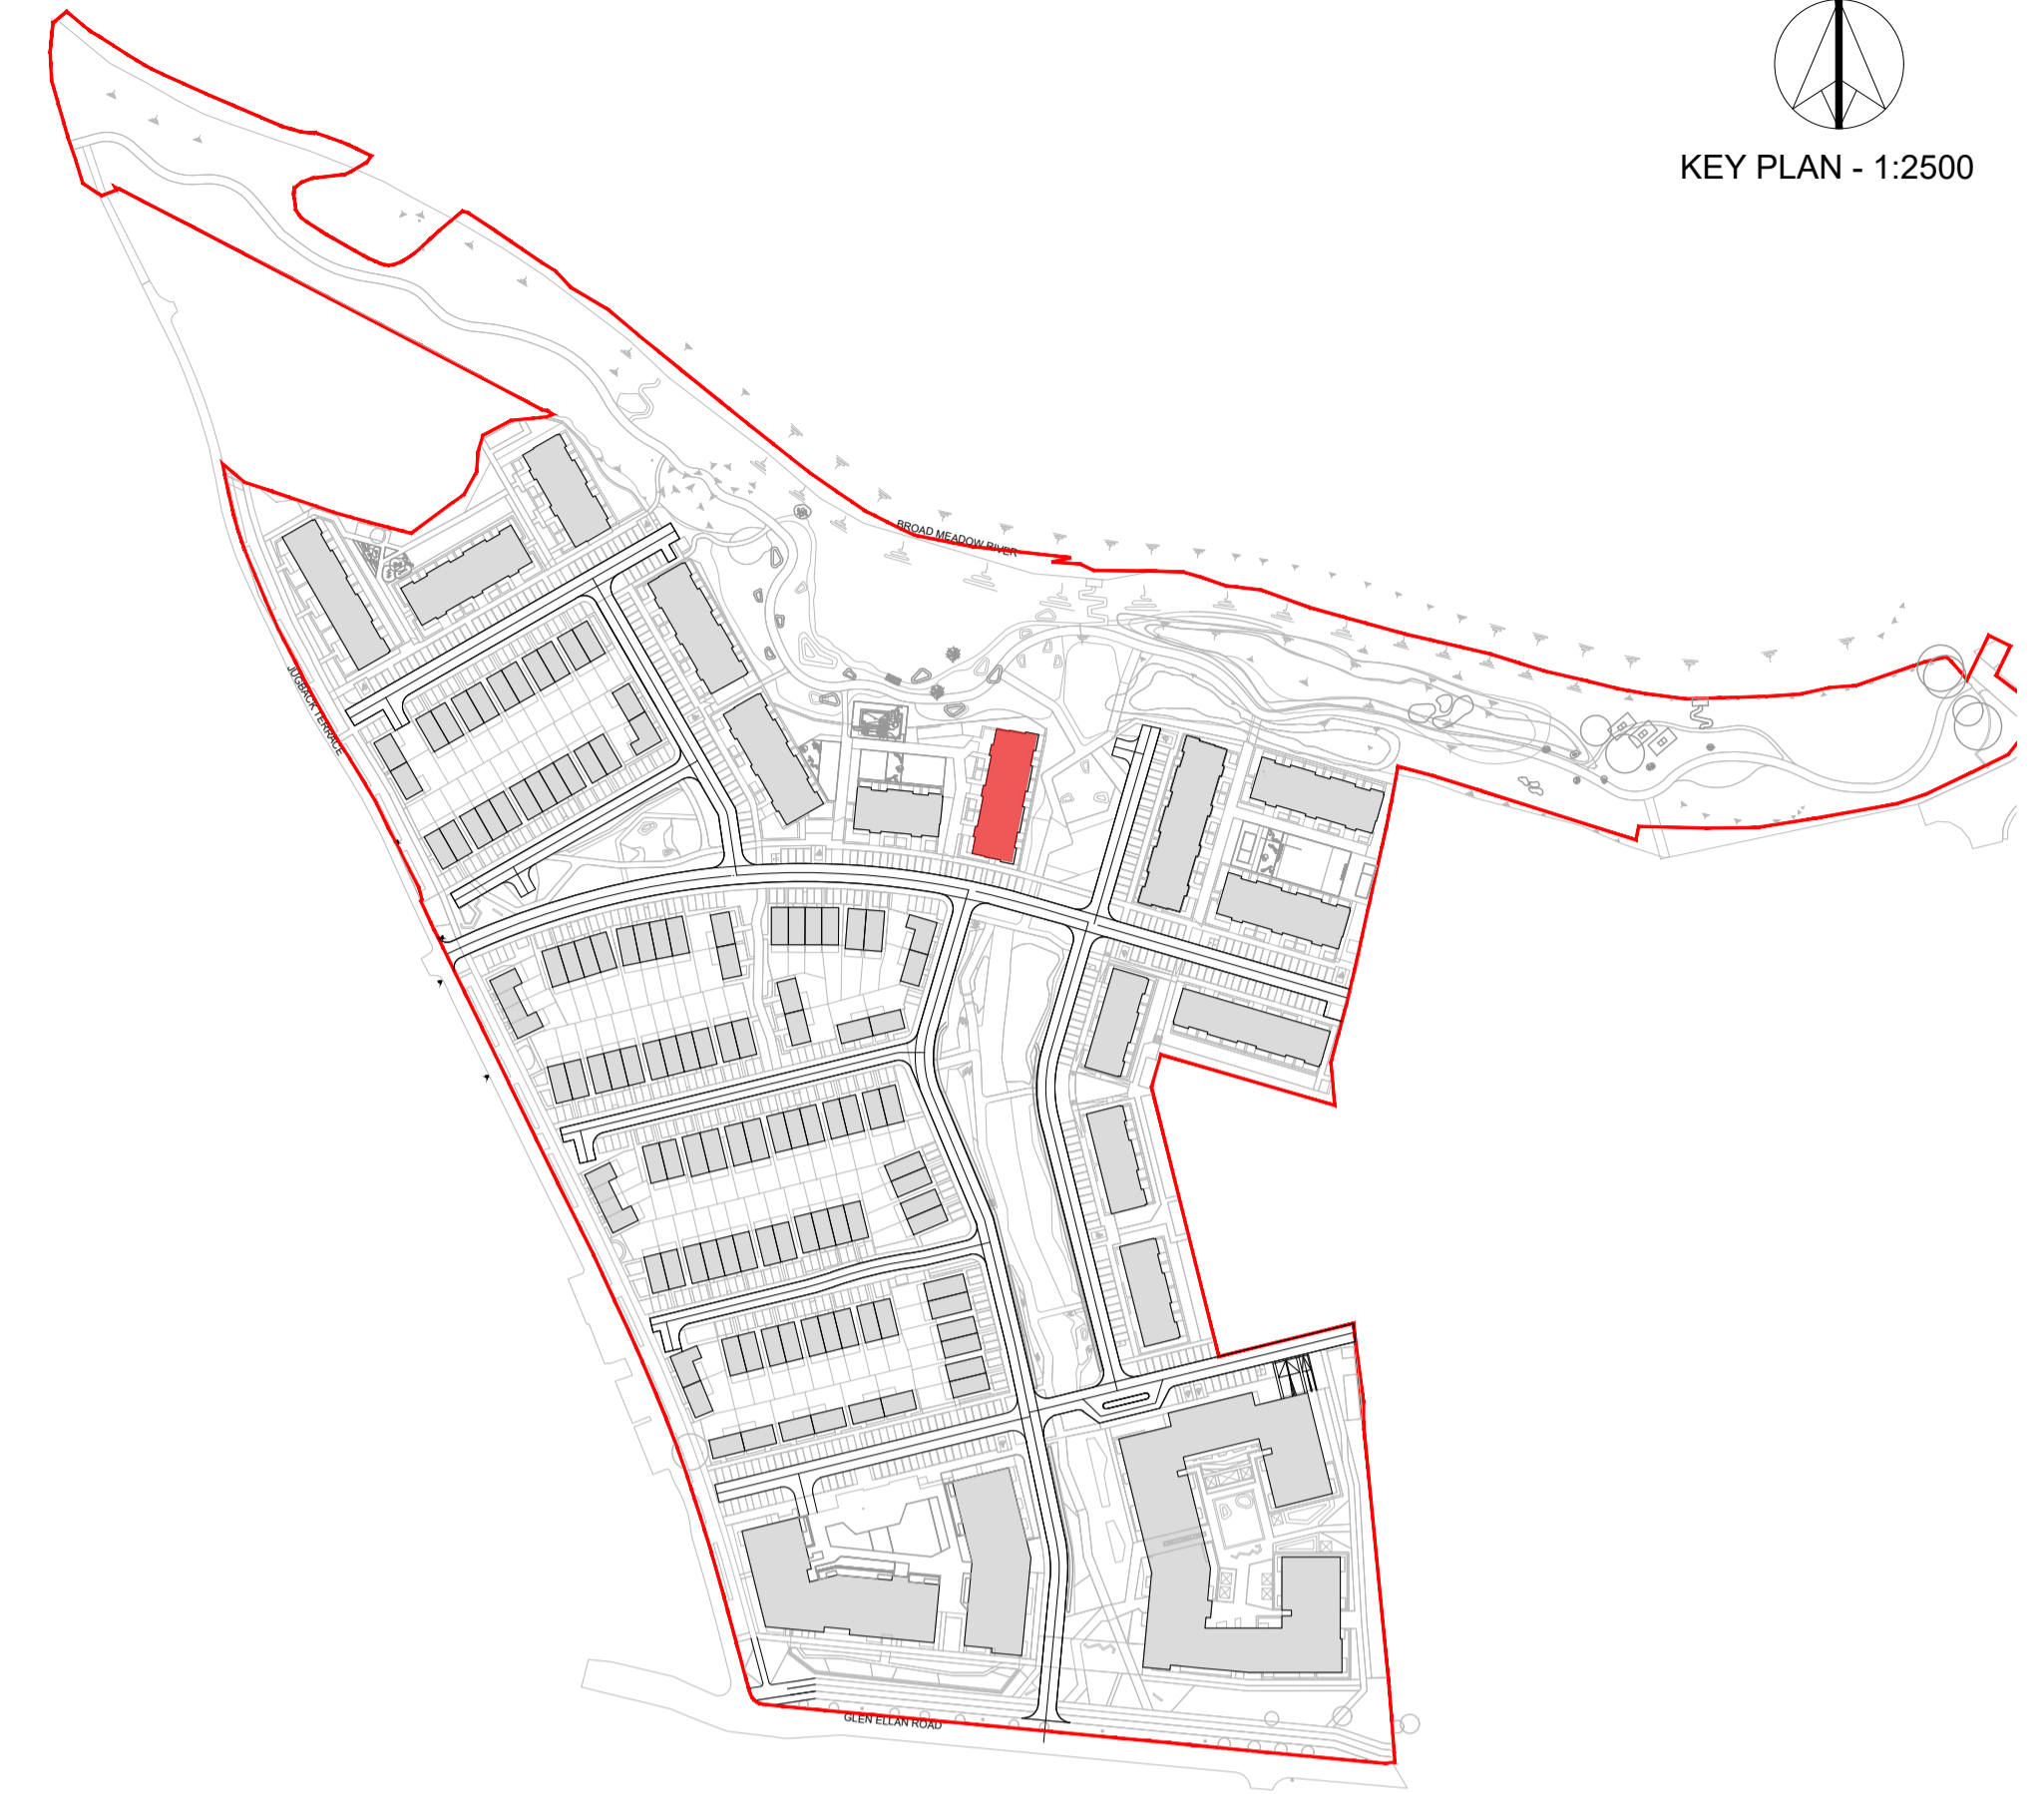

GENERAL NOTES

THIS DRAWING TO BE READ IN CONJUNCTION WITH ARCHITECT'S DRAWINGS, CONSULTANT ENGINEER'S DRAWINGS AND SPECIFICATIONS & LANDSCAPE ARCHITECT'S DRAWINGS REFER TO ARCHITECT'S SITE PLAN PL04 FOR NORTH ORIENTATION.

LEVELS GIVEN ON HOUSE TYPE DRAWINGS ARE GIVEN TO A LOCAL ABSOLUTE ZERO LEVEL. FOR SPECIFIC LEVELS DEPENDING ON INDIVIDUAL UNIT LOCATION, REFER TO ARCHITECT'S CONTEXT SECTIONS AND ENGINEER'S DRAWINGS WHERE LEVELS ARE ALL GIVEN IN RELATION TO LAND SURVEYOR'S BENCHMARK BASED ON MALIN HEAD DATUM LEVEL.

NOTES ON FINISHES:

- ROOF: TO BE FINISHED IN SLATE OR CONCRETE ROOF TILES IN SELECTED COLOUR OR SIMILAR APPROVED.
WALLS: SELECTED BRICKWORK WHERE INDICATED OTHERWISE PAINTED SAND / CEMENT RENDER OR SELF COLOURED RENDER.
JOINERY: ALL WINDOWS AND DOORS, FRAMES AND LEAVES, TO BE ALUMINIUM POWDER-COATED TO APPROVED COLOUR OR UPVC, OBSCURE GLAZING WHERE INDICATED TO SENSITIVE WINDOWS.
RAINFATHER GOODS: GUTTERS, DOWNPIPES, AND FIXINGS TO BE UPVC OR ALUMINIUM POWDER COATED TO SELECTED COLOUR TO MATCH ROOF SLATES

Table with 3 columns: Unit Type (A1, A3, A6, A7, A11), Description (e.g., TYPE A1 1 STOREY 2 BED), and Area (e.g., 82m² / 883ft²).

NOTES:

DO NOT SCALE FROM DRAWINGS. WORK TO FIGURED DIMENSIONS ONLY. ARCHITECT TO BE NOTIFIED OF ALL DISCREPANCIES.

Table with 2 columns: CLIENT (CAIRN) and REVISIONS (DATE, DESCRIPTION, No.).

Table with 2 columns: PROJECT TITLE (SHD AT HOLYBANKS, SWORDS) and DRAWING TITLE (Duplex Block G Plans, Section & Elevations), including date, scale, and drawing ID.